



SOUTH BUILDING ELEVATION

SCALE: 1/16" = 1'-0"

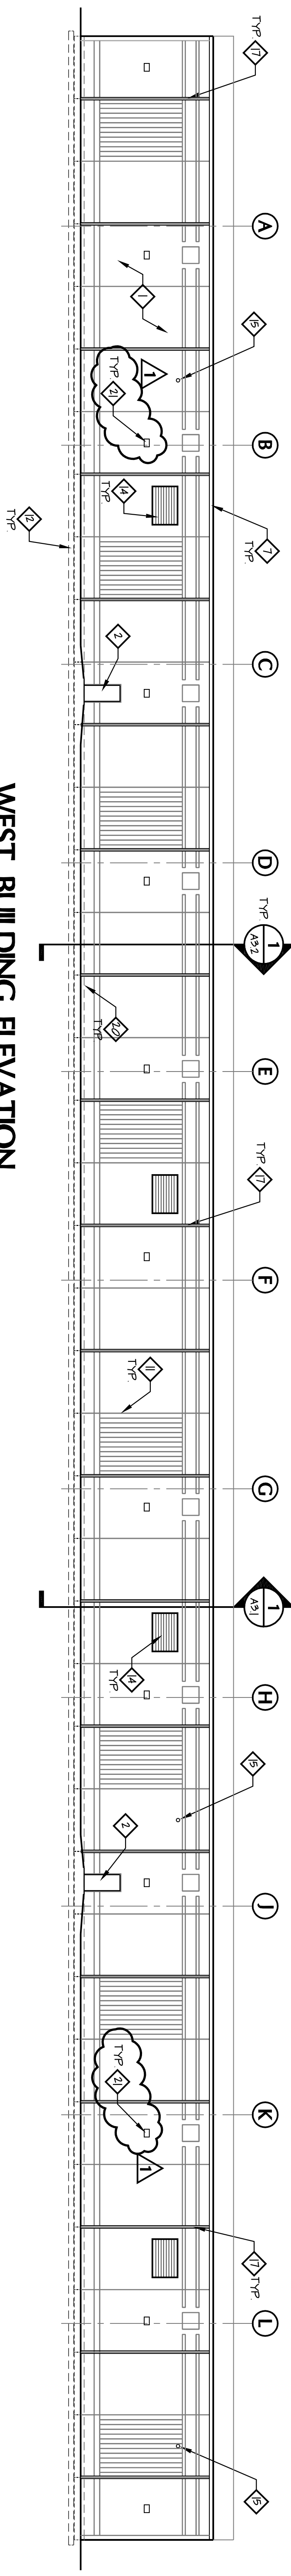


WEST BUILDING ELEVATION

SCALE: 1/16" = 1'-0"

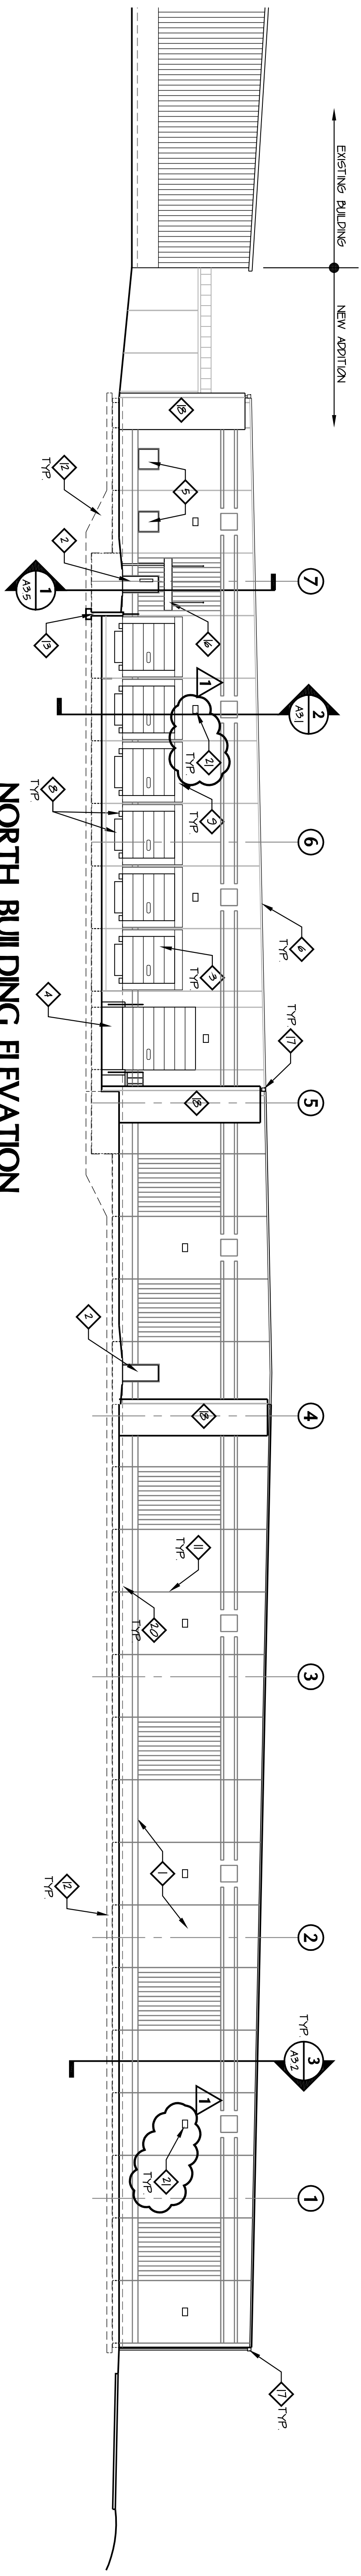

NORTH BUILDING ELEVATION

SCALE: 1/16" = 1'-0"

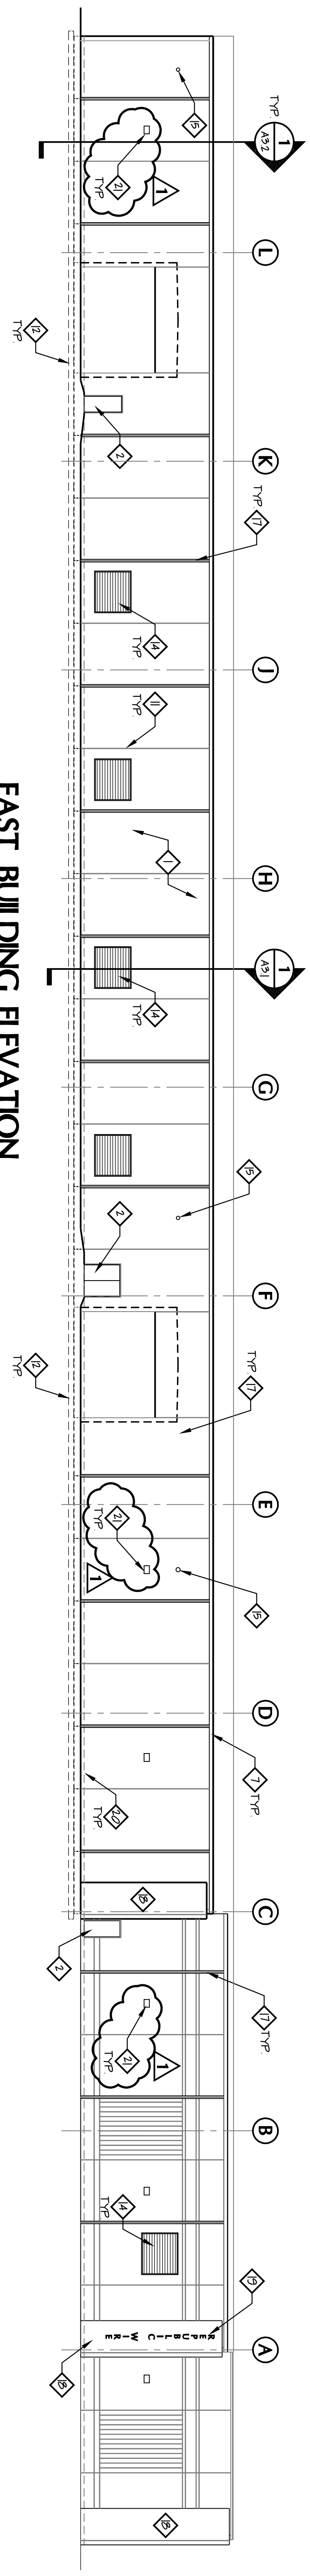

EAST BUILDING ELEVATION

SCALE: 1/16" = 1'-0"

GENERAL NOTES

- 1. SEE SHEET A22 FOR TYPICAL PRECAST PANELS AND DETAILS
- 2. PANELS TO BE PAINTED PER OWNER'S PREFERENCE

DRAWING NOTES

- 1. INSULATED PRECAST CONCRETE PANELS - TYP AT EXTERIOR WALLS
- 2. HOLLOW METAL DOOR AND FRAME - SEE DOOR SCHEDULE
- 3. SECTIONAL OVERHEAD DOOR WITH VISION PANEL - SEE ENLARGED PLANS FOR SIZE REQUIREMENTS - SEE SPECIFICATIONS FOR ADDITIONAL INFORMATION
- 4. CONCRETE GRAB-ON GRADE DRIVE-UP RAMP WITH CAST IN PLACE WALLS - SEE STRUCTURAL DRAWINGS
- 5. ALUMINUM FRAMED WINDOW - SEE WINDOW SCHEDULE
- 6. PRE-FINISHED METAL CORING BY PRE-ENGINEERED METAL BUILDING MANUFACTURER
- 7. PRE-ENGINEERED METAL GUTTER BY PRE-ENGINEERED METAL BUILDING MANUFACTURER
- 8. DOOR LEVELER AND DOOR PLUMBERS - SEE SPECIFICATIONS
- 9. DOOR SEAL - SEE SPECIFICATIONS
- 10. PRE-ENGINEERED METAL DOWNPOUT CONNECTED TO SITE STORM SYSTEM - SEE SITE UTILITY PLAN - PROVIDE STEEL PROTECTOR FOOT FROM GRADE UP TO FINISH FLOOR LINE
- 11. 3/4" WIDE JOINT BETWEEN PRECAST PANELS
- 12. CONCRETE FOOTINGS / FOUNDATION - SEE STRUCTURAL DRAWINGS

DRAWING NOTES

- 13. 8" THICK CONCRETE CAST-IN-PLACE WALL SHOWN IN SECTION - SEE CIVIL DRAWINGS AND STRUCTURAL DRAWINGS
- 14. MECHANICAL COVER - SEE MECHANICAL DRAWINGS FOR SIZE AND MOUNTING HEIGHT INFORMATION - ALL OPENINGS TO BE CENTER ON PRECAST PANEL. TYP - PROVIDE SHOP COORDINATION DRAWINGS ILLUSTRATING ALL PANELS AND PANEL OPENINGS
- 15. SEE WALL VENT CAP - SEE MECHANICAL DRAWINGS - PENETRATION TO BE ILLUSTRATING ALL PANELS AND PANEL OPENINGS
- 16. CENTERED ON PRECAST PANEL. TYP - PROVIDE SHOP COORDINATION DRAWINGS ILLUSTRATING ALL PANELS AND PANEL OPENINGS
- 17. CARPENTER ALUMINUM PANEL GANDY - SEE SHEET A25 - CENTER ON PRECAST PANEL
- 18. APPROPRIATE LOCATION OF DOWNPOUT BY PRE-ENGINEERED METAL BUILDING MANUFACTURER - MAX DOWNPOUT SPACING SHALL BE 10' - PROVIDE SHOP COORDINATION DRAWINGS AND COORDINATE FINAL LOCATION WITH ARCHITECT IN FIELD - PROVIDE CAST IRON DOWNPOUT FOOT
- 19. 1-3/4" THICK CORNER PRECAST PANEL - SEE ENLARGED PLANS AND SHEET A22 FOR CORNER PLAN DETAIL - HOLD TOP OF CORNER PANEL 4" MIN. BELOW METAL FASCIA / GUTTER - TYP
- 20. METAL CORNER PROTECTOR SHALL BE VERTICALLY ON CORNER PANEL - CENTER LETTERS BETWEEN EDGE AND FACE JOINT - HOLD TOP LETTER 1'-4" BELOW TOP OF PANEL
- 21. DASHED LINE REPRESENTS FINISHED FLOOR LINE

DRAWING NOTES

- 22. EXTERIOR WALL MOUNTED LIGHT FIXTURE - SEE ELECTRICAL DRAWINGS



McCall Smith Punshon, Inc.
 3700 Park 42 Drive Suite 1908
 Cincinnati, Ohio 45241-2097
 Tel. 513-759-0004 • Fax 513-563-7099
 Engineers • Architects • Surveyors
 Planners • Landscape Architects

Drawn By: DCC Project Mgr. RGM
 CAD File: 973332-41
 X-Ref File

Issue/Revision	Revision Number	Date
FOR PERMIT	07/18/12	
FOR CONSTRUCTION	1	08/22/12

© COPYRIGHT 2010, MCCALL SMITH PUNSHON, INC.

NEW WAREHOUSE EXPANSION
 FOR
Republic Wire
 UNION CENTRE DRIVE
 WEST CHESTER, OHIO 45069

Sheet Title	BUILDING ELEVATIONS
Project No.	9733332
Scale	AS NOTED
Sheet No.	A2.1
File No.	97333 32